

5. Application Drawings


Land adjacent to Common Road, Harthill, Rotherham


Construction of a well site and creation of a new access track, mobilisation of drilling, ancillary equipment and contractor welfare facilities to drill and pressure transient test a vertical hydrocarbon exploratory core well and mobilisation of workover rig, listening well operations, and retention of the site and wellhead assembly gear for a temporary period of five years on land adjacent to Common Road, near Harthill.

May 2017

List of Application Plans

P304-S2-PA-00 Rev A	Strategic Location Plan
P304-S2 -PA-01 Rev G	Application Site Plan
P304-S2-PA-04 Rev C	Existing Ground Plan
P304-S2-PA-05 Rev B	Proposed Site Entrance & Highway works
P304-S2-PA-06 Rev C	Proposed Site Layout Plan - Construction
P304-S2-PA-07 Rev F	Proposed Site Layout Plan - Drilling Stage
P304-S2-PA-08 Rev B	Proposed Site Layout Plan - Listening Stage
P304-S2-PA-09 Rev B	Proposed Site Restoration
P304-S2-PA-10 Rev B	Proposed Lighting Plan - Drilling & Coring
P304-S2-PA-11 Rev B	Proposed Drainage Plan
P304-S2-PA-12 Rev B	Proposed Site Layout Plan - Suspension
P304-S2-PA-13 Rev B	Proposed Internal Access Plan
P304-S2-PA-16 Rev A	Proposed Sections & Details
P304-S2-PA-17 Rev B	Proposed Site Layout Plan - Possible workover
P304-S2-PA-21 Rev A	Parameter Sections - Develop. & Establish
P304-S2-PA-22 Rev A	Parameter Sections - Drilling & Coring
P304-S2-PA-23 Rev A	Parameter Sections - Suspension
P304-S2-PA-24 Rev A	Parameter Sections - Work over of Well
P304-S2-PA-25 Rev A	Parameter Sections - Listening Stage
P304-S2-PA-26 Rev A	Parameter Sections – Abandonment
P304-S2-PA-30 Rev A	Heras Fence Details
P304-S2-PA-31	Lighting Examples

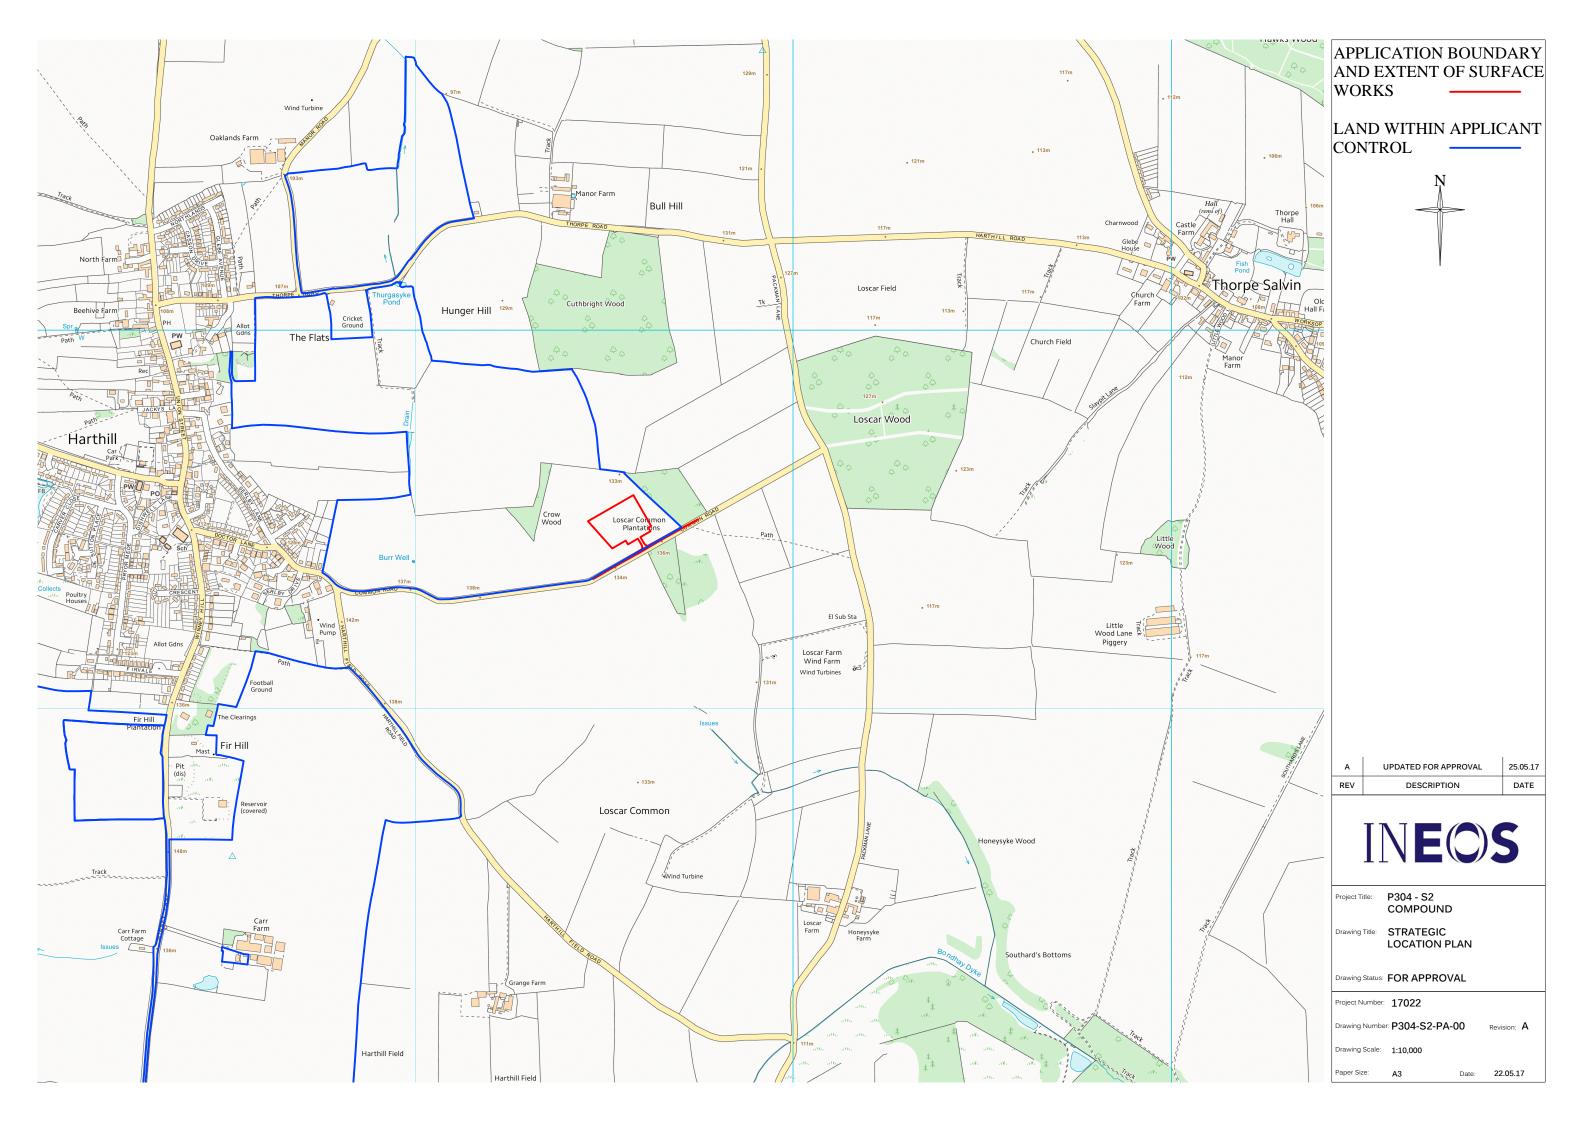

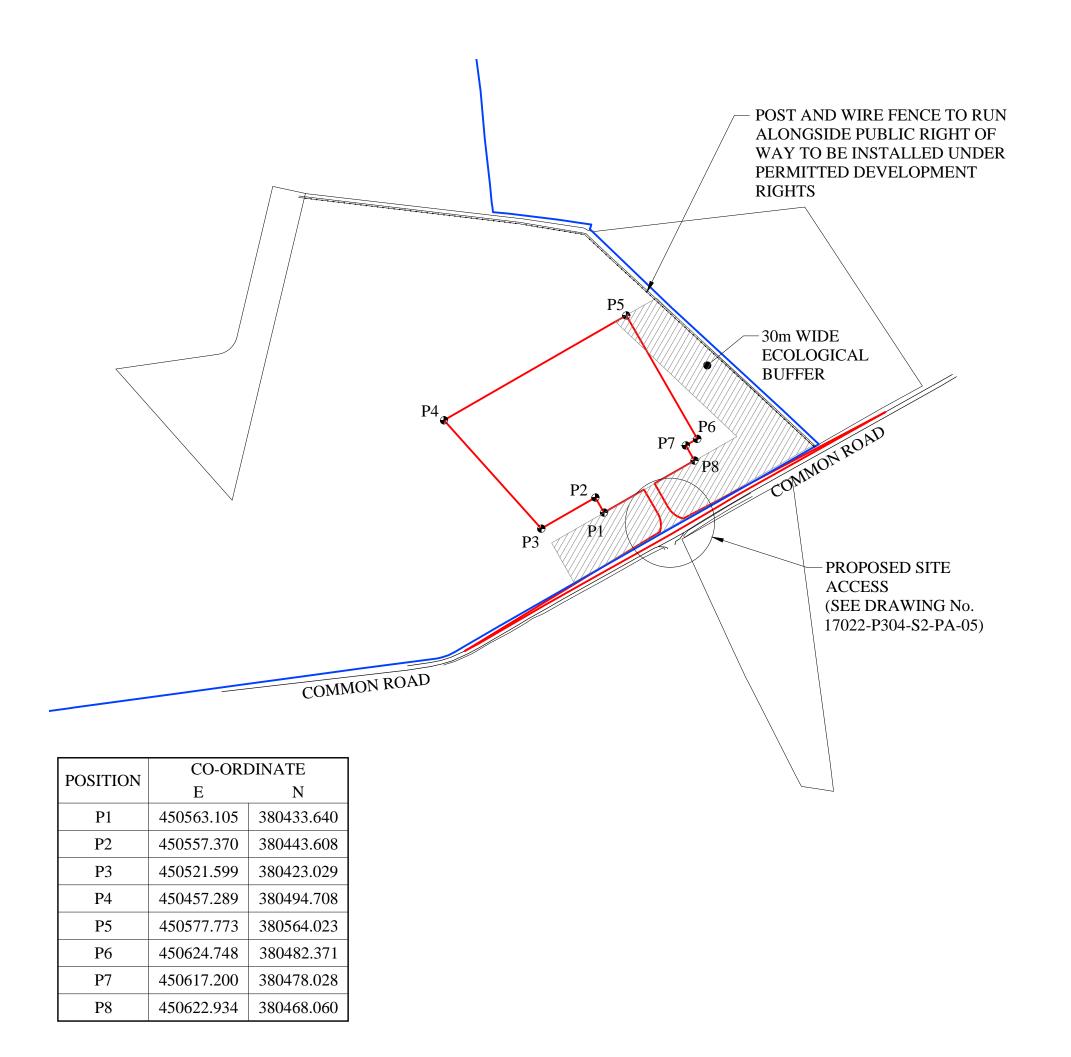

APPLICATION BOUNDARY
AND EXTENT OF SURFACE
WORKS

LAND WITHIN APPLICANT CONTROL



G	UPDATED FOR APPROVAL	25.05.17
F	UPDATED FOR APPROVAL	22.05.17
E	SITE POSITION ADJUSTED.	17.05.17
D	UPDATED FOR APPROVAL	11.05.17
С	UPDATED FOR APPROVAL	09.05.17
В	ECOLOGICAL BUFFER SHOWN. PERIMETER FENCE SHOWN. P4 RE-LOCATED.	03.05.17
Α	CO-ORDINATES UPDATED TO SUIT BLUE LINE.	25.04.17
REV	DESCRIPTION	DATE



Project Title: P304 - S2 COMPOUND

Drawing Title: APPLICATION SITE PLAN

Drawing Status: APPROVAL


Project Number: 17022

Drawing Number: P304-S2-PA-01

Drawing Scale: 1:2500

Paper Size: A3 Date: 06.04.17



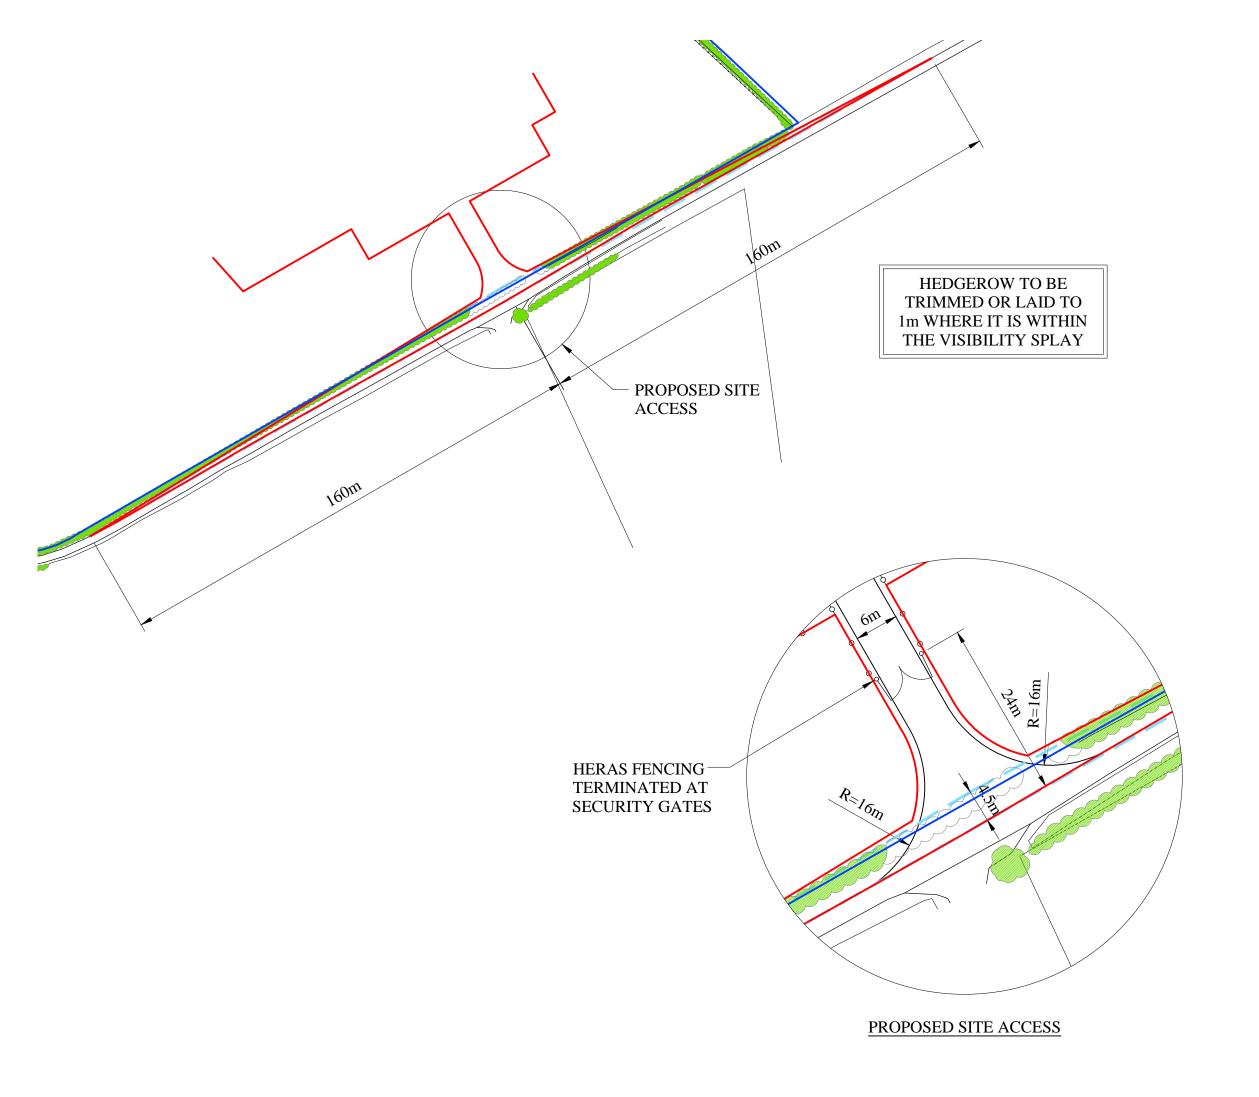

APPLICATION BOUNDARY
AND EXTENT OF SURFACE
WORKS

LAND WITHIN APPLICANT CONTROL

VISIBILITY SPLAYS 4.5m x 160m



	ı	i
В	UPDATED FOR APPROVAL	22.05.17
Α	UPDATED FOR APPROVAL	18.05.17
REV	DESCRIPTION	DATE



pject Title: P304 - S2 COMPOUND

PROPOSED SITE ENTRANCE AND HIGHWAY WORKS PLAN

Drawing Status: APPROVAL


Project Number: 17022


Drawing Number: P304-S2-PA-05


Drawing Scale: 1:1000/500


Paper Size: A3 Date: 10.05.17


1.1000/5

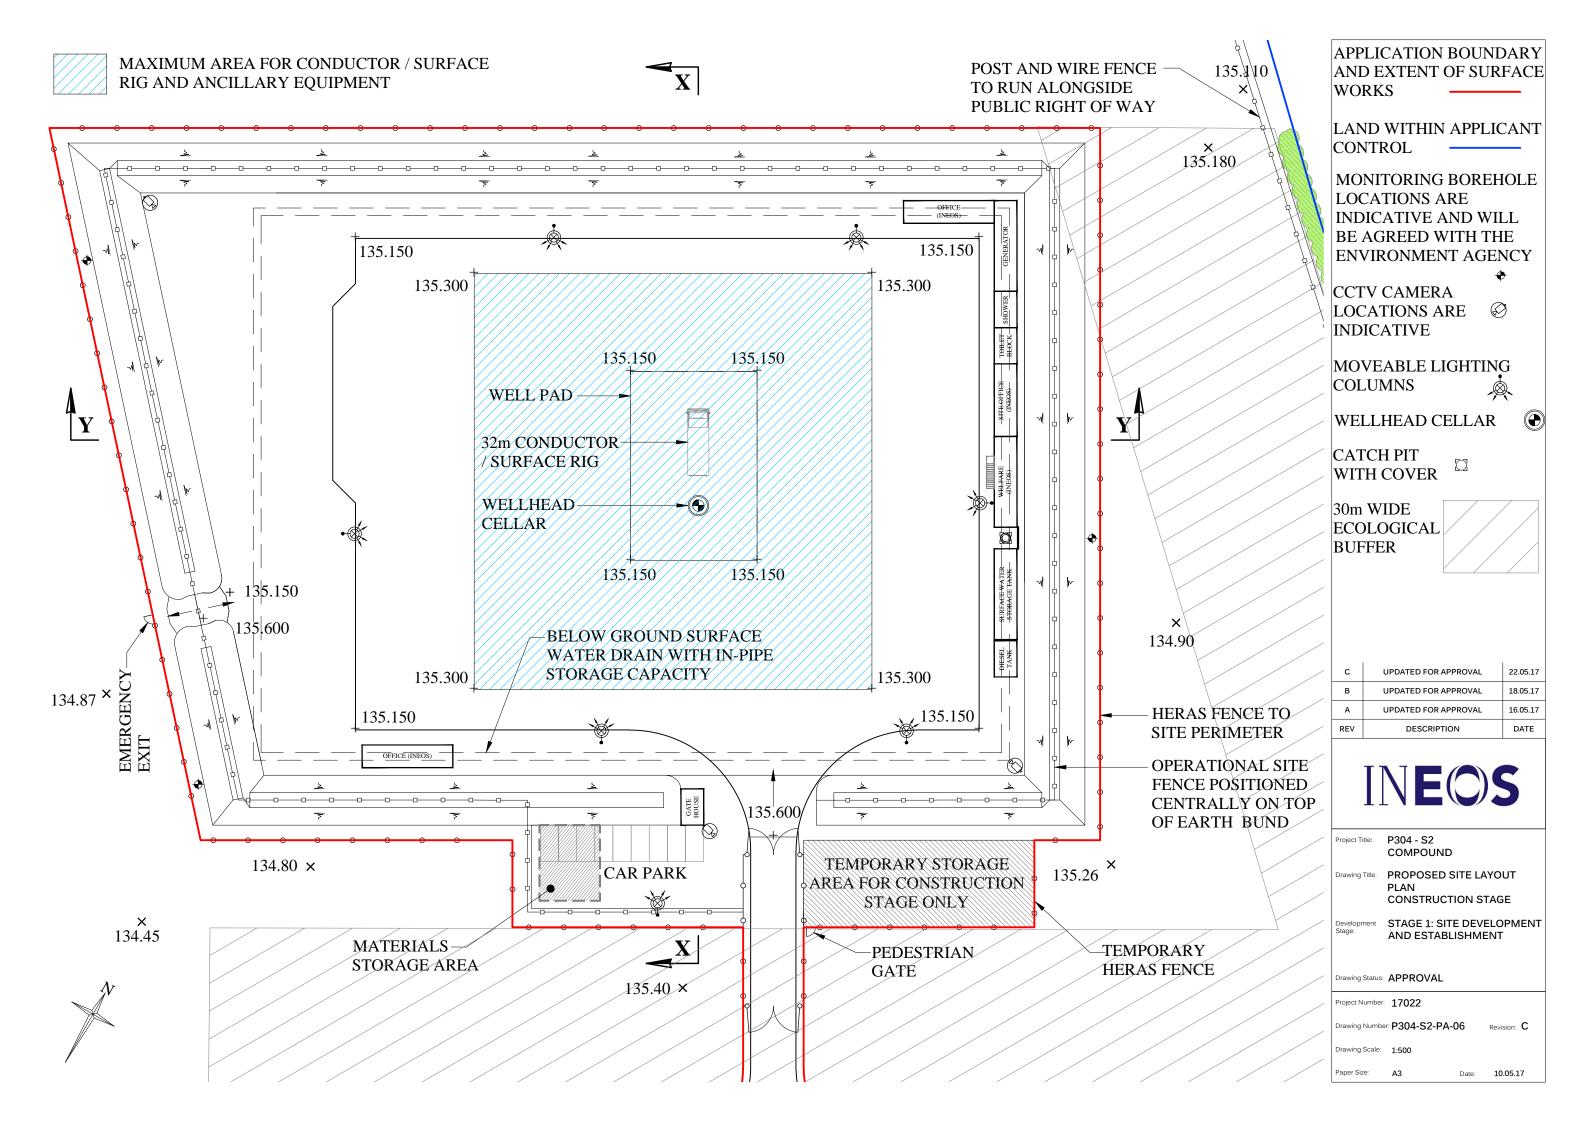


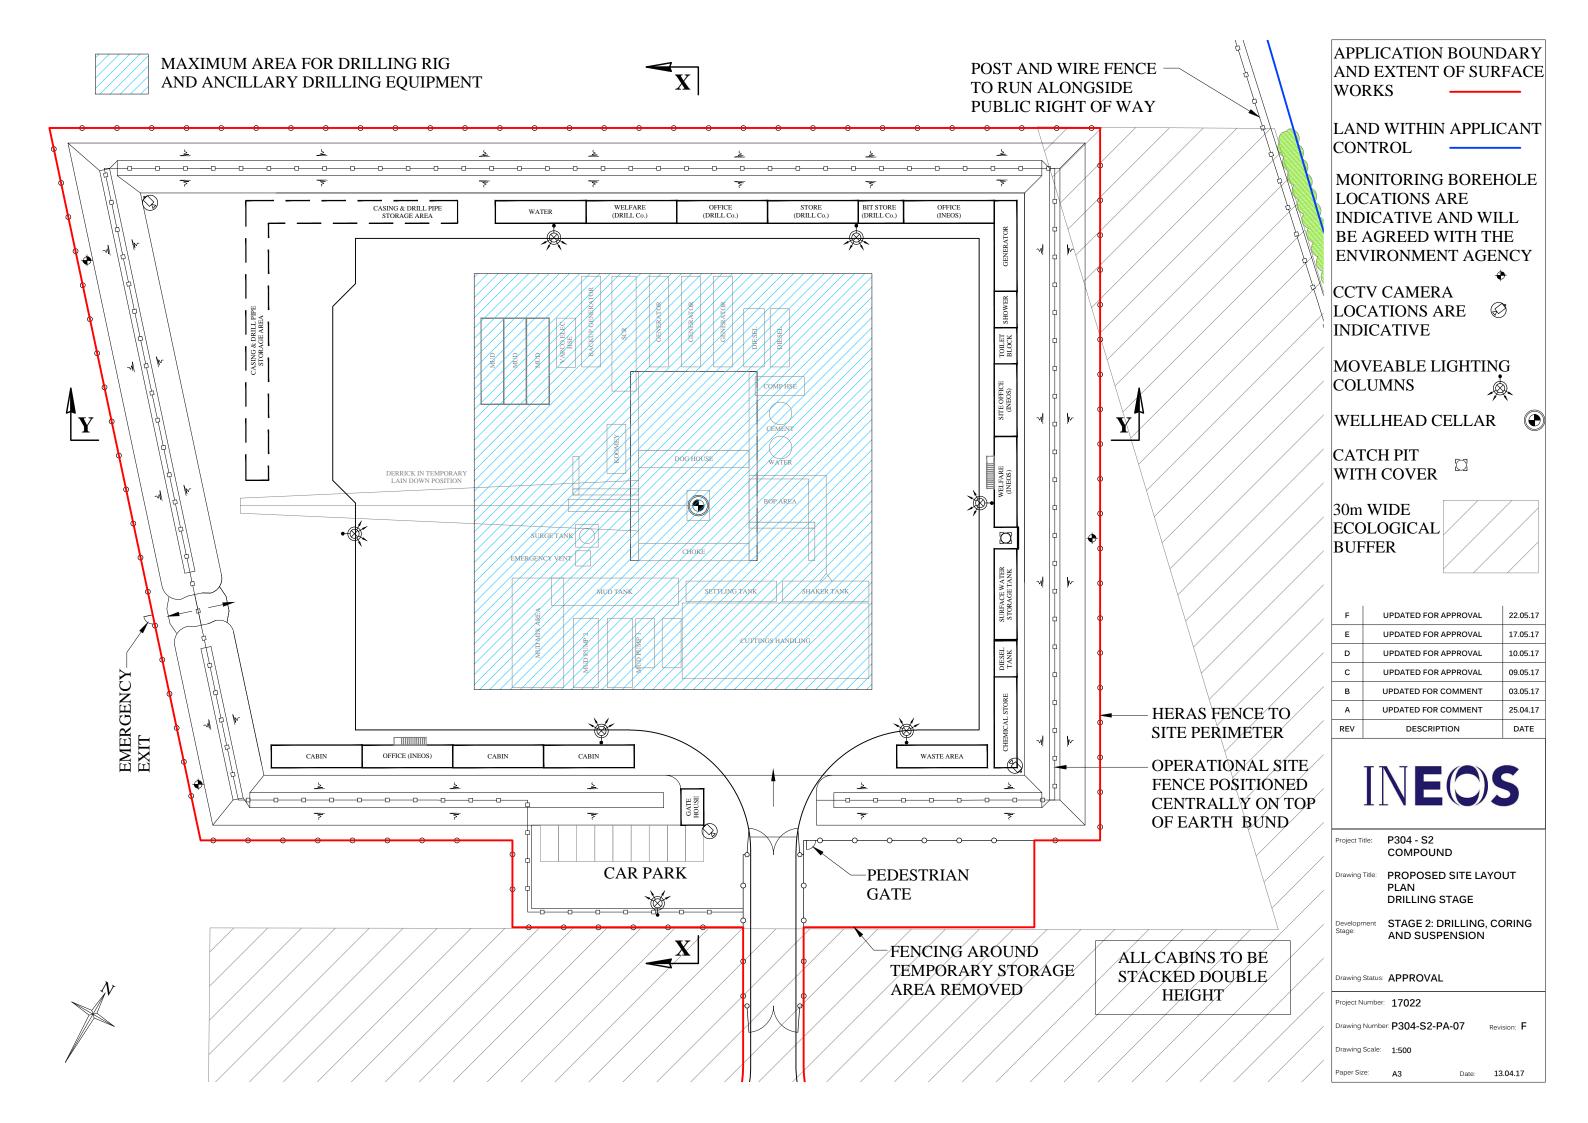


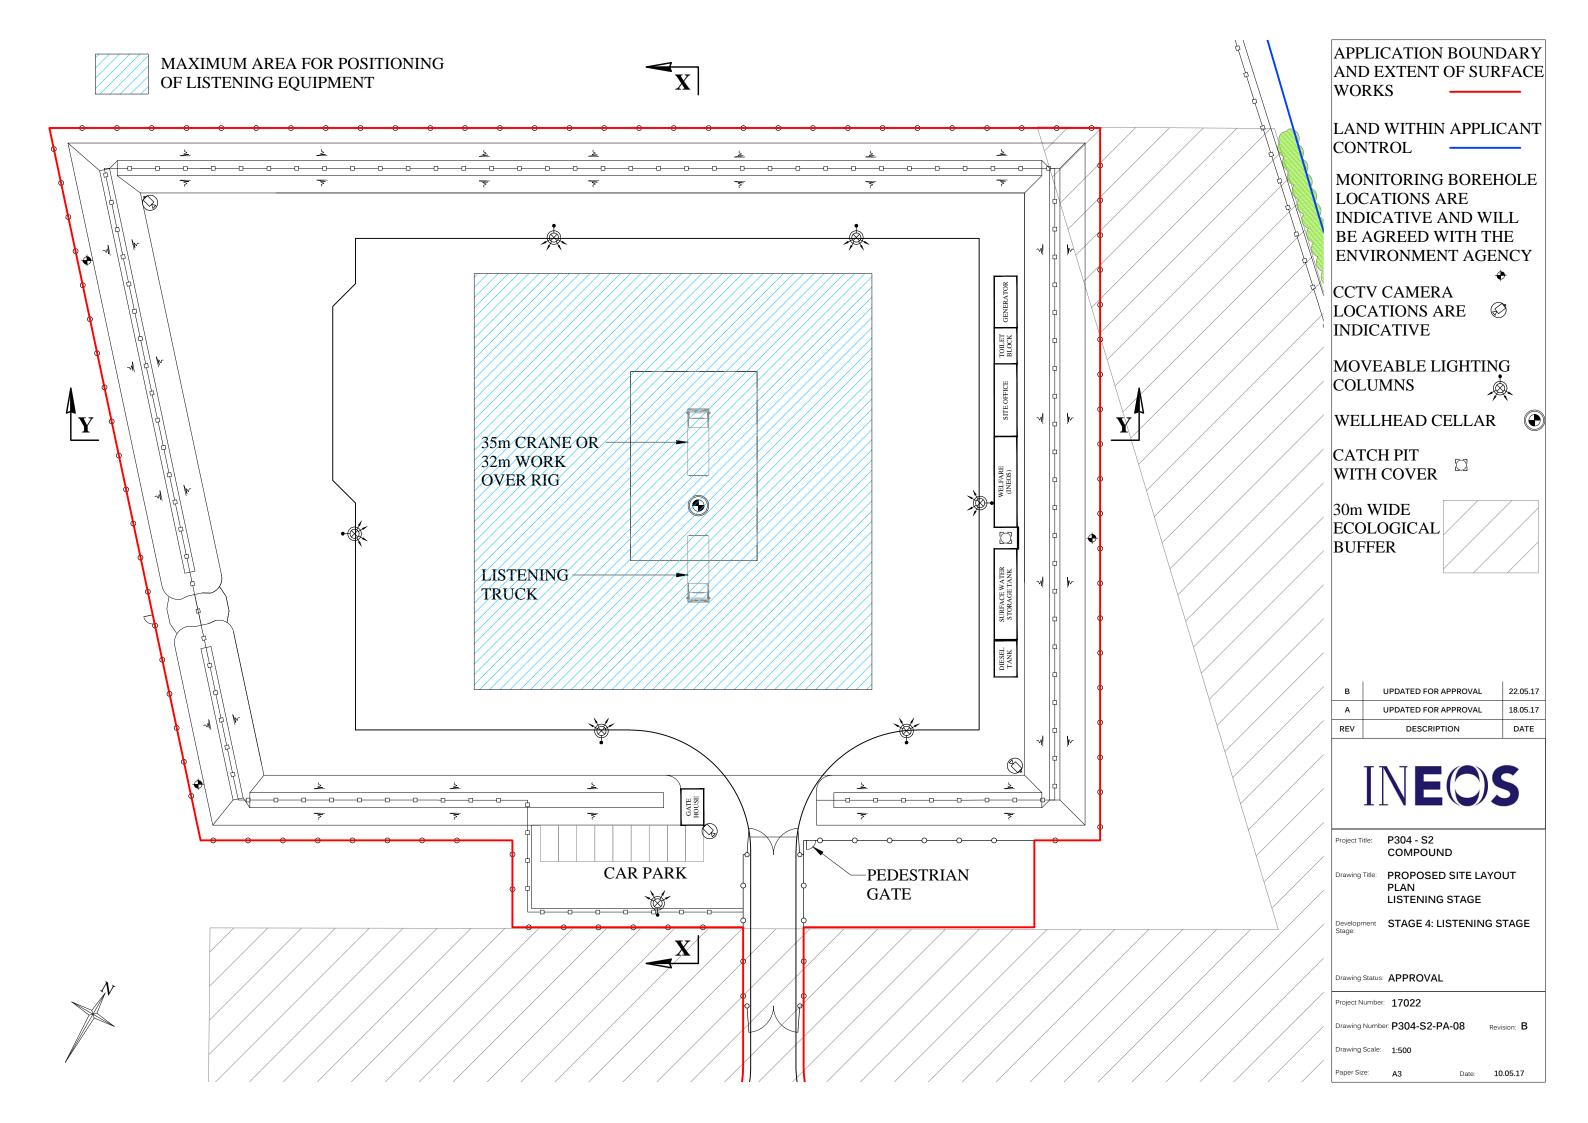


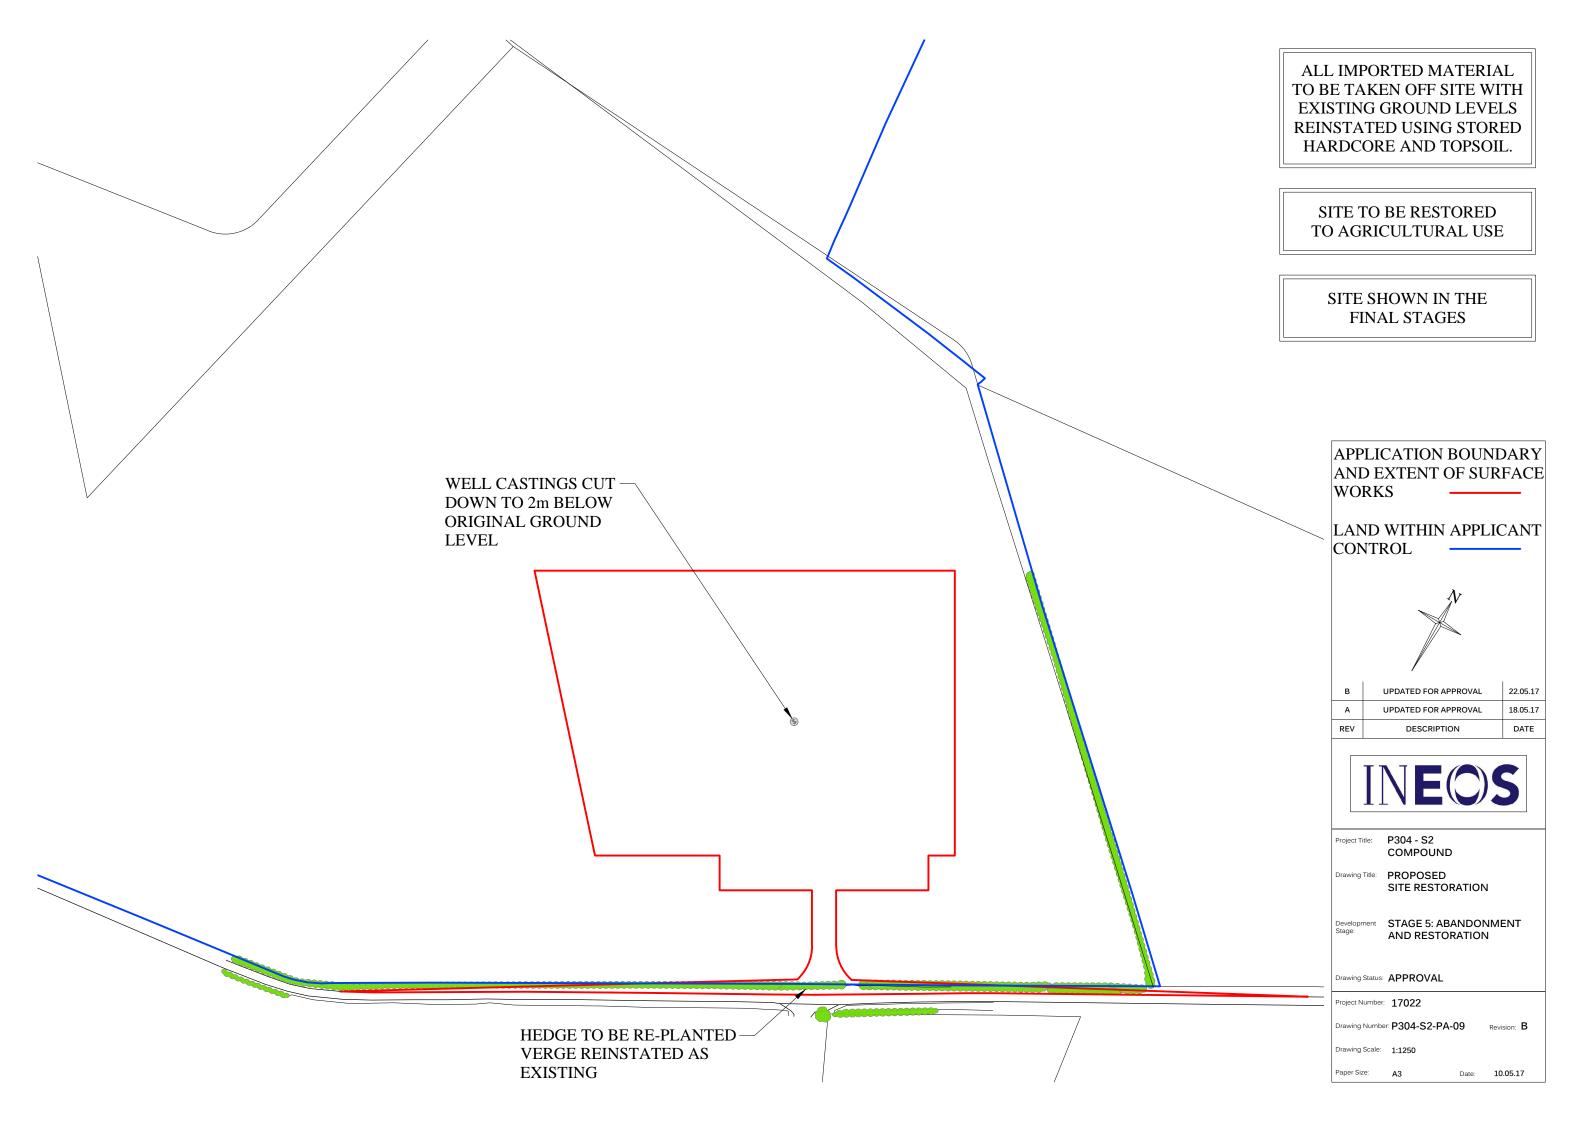


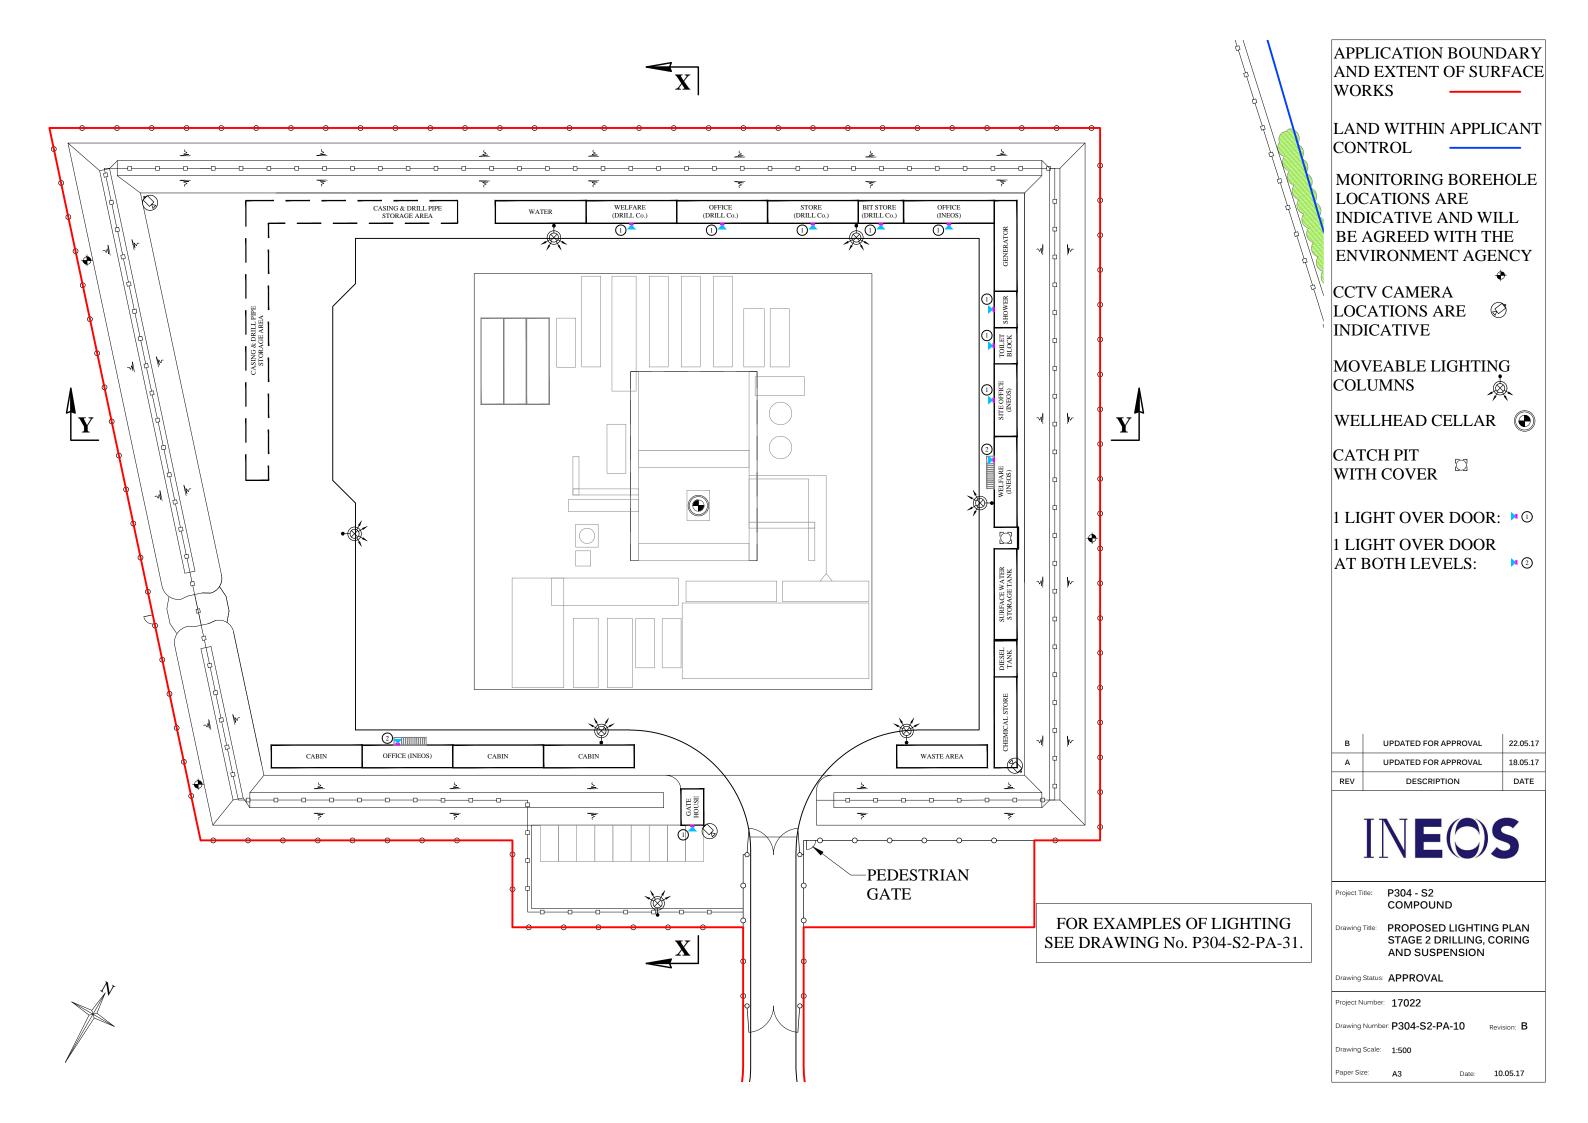


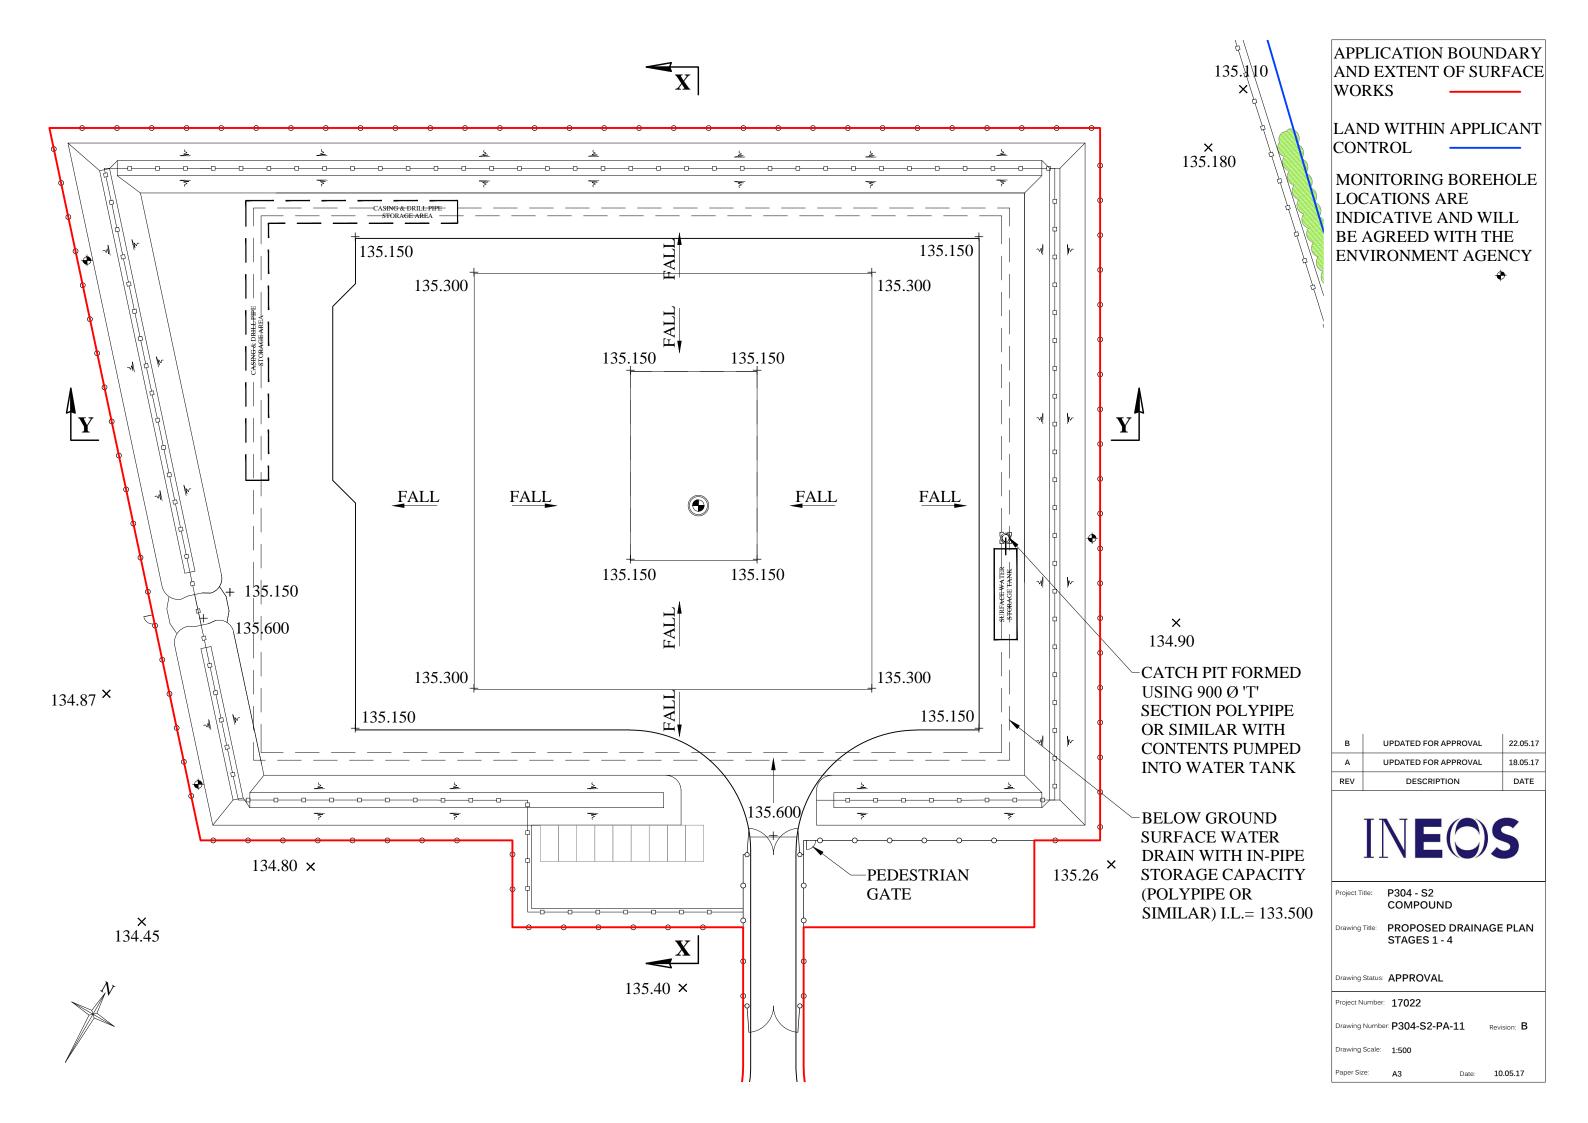


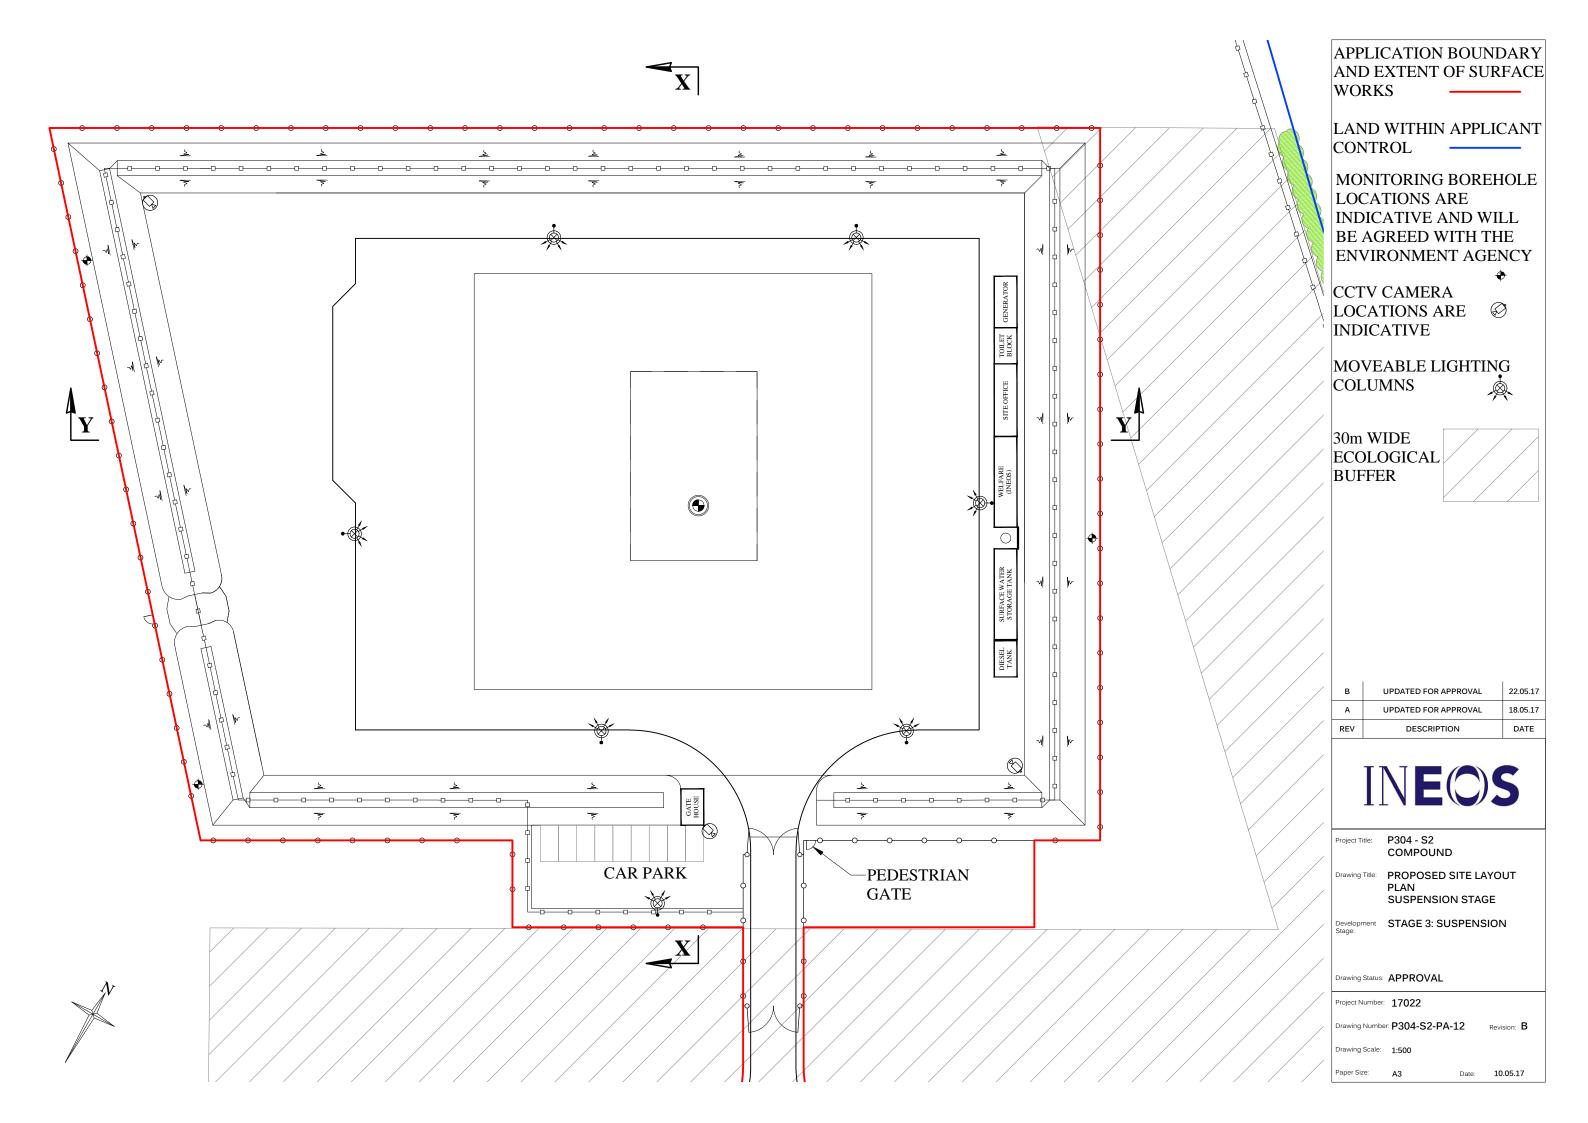


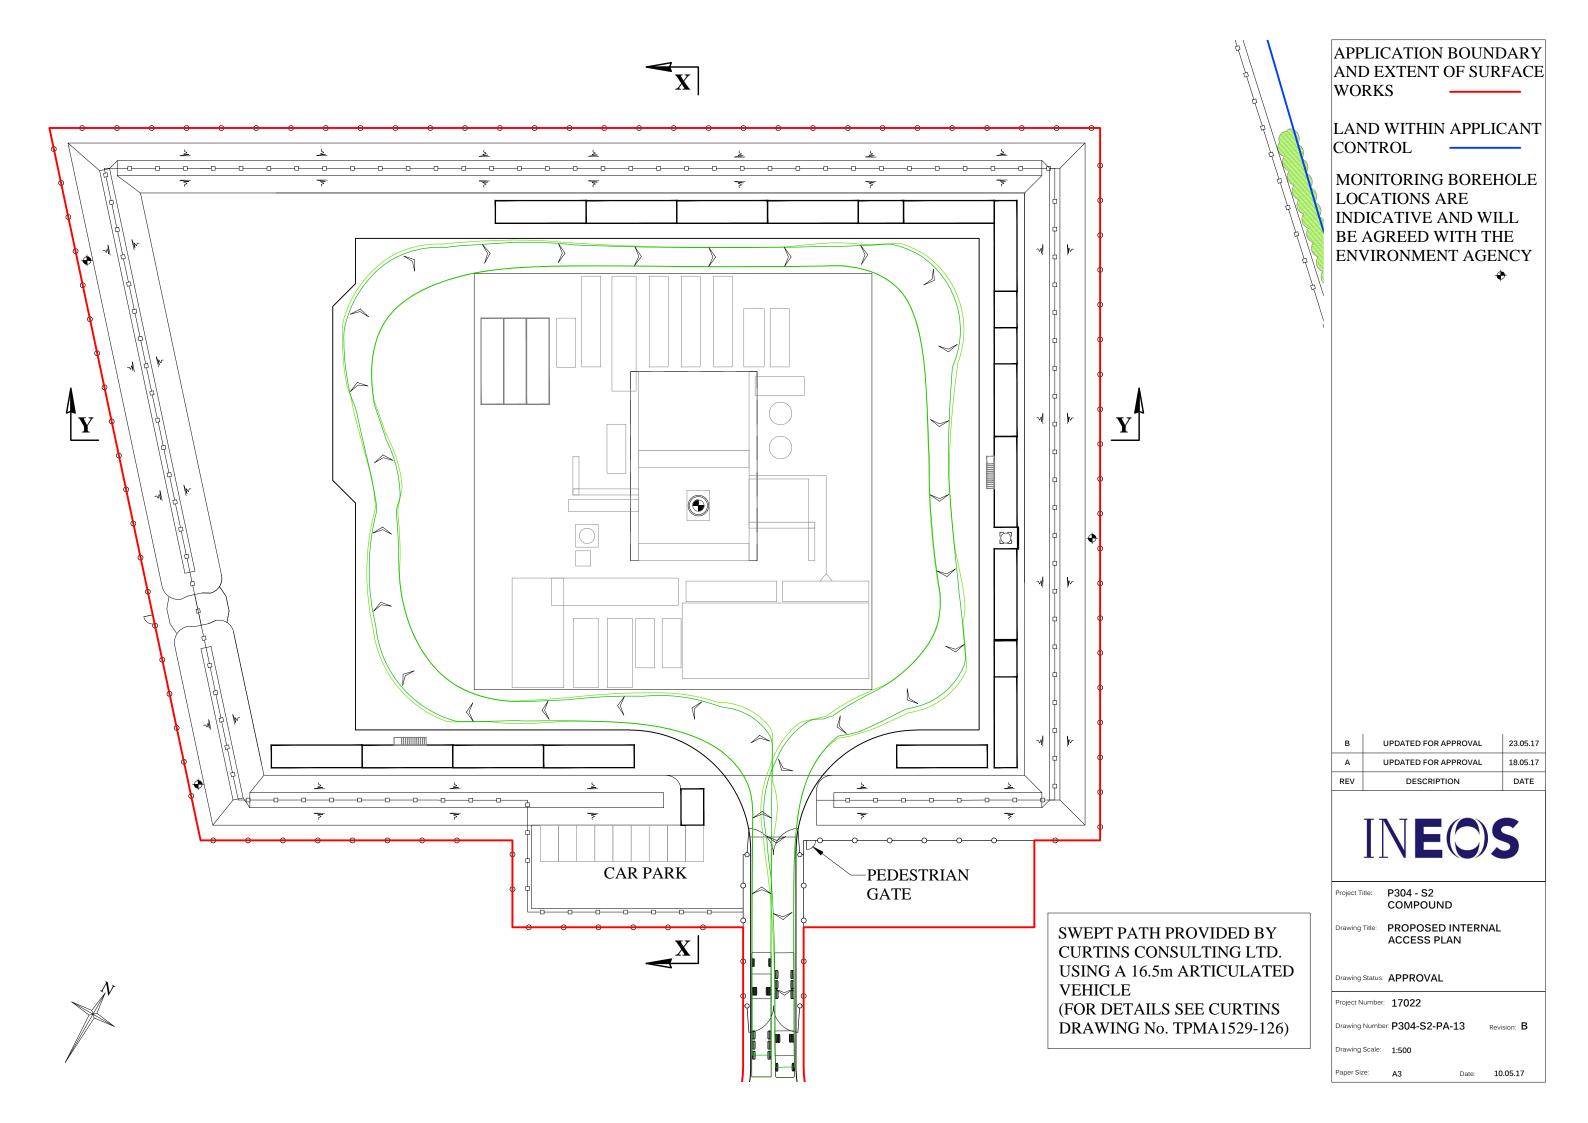

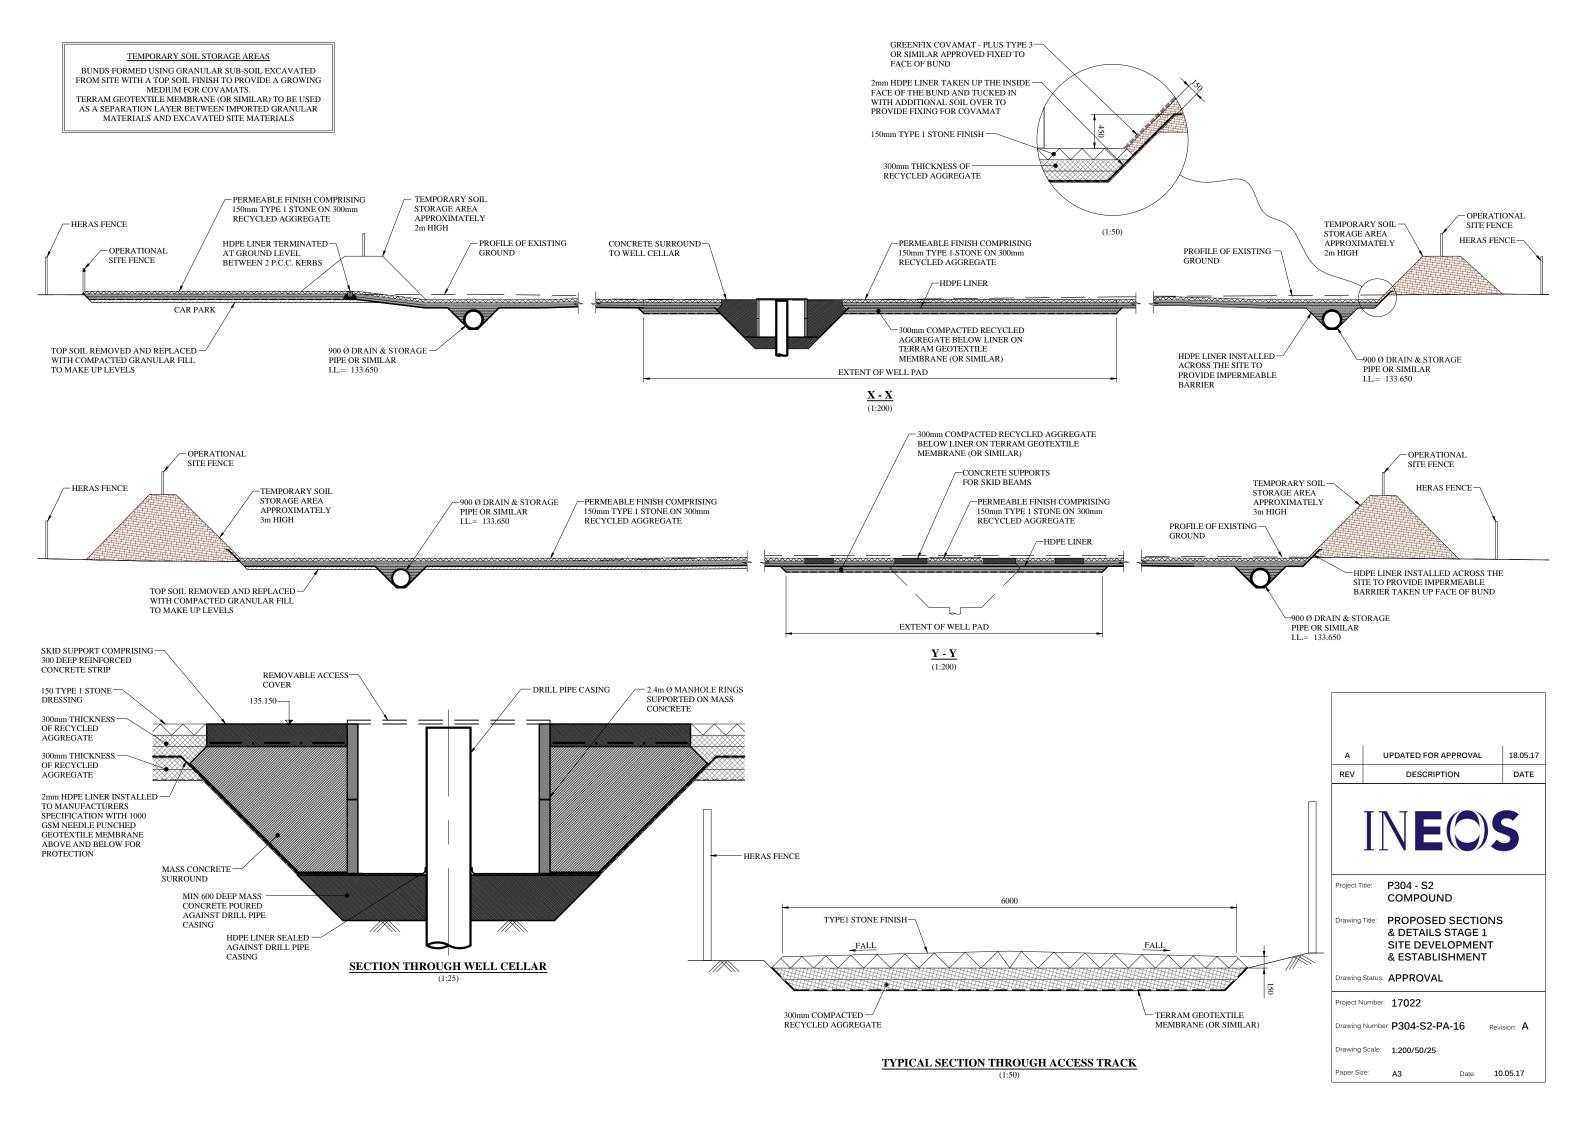

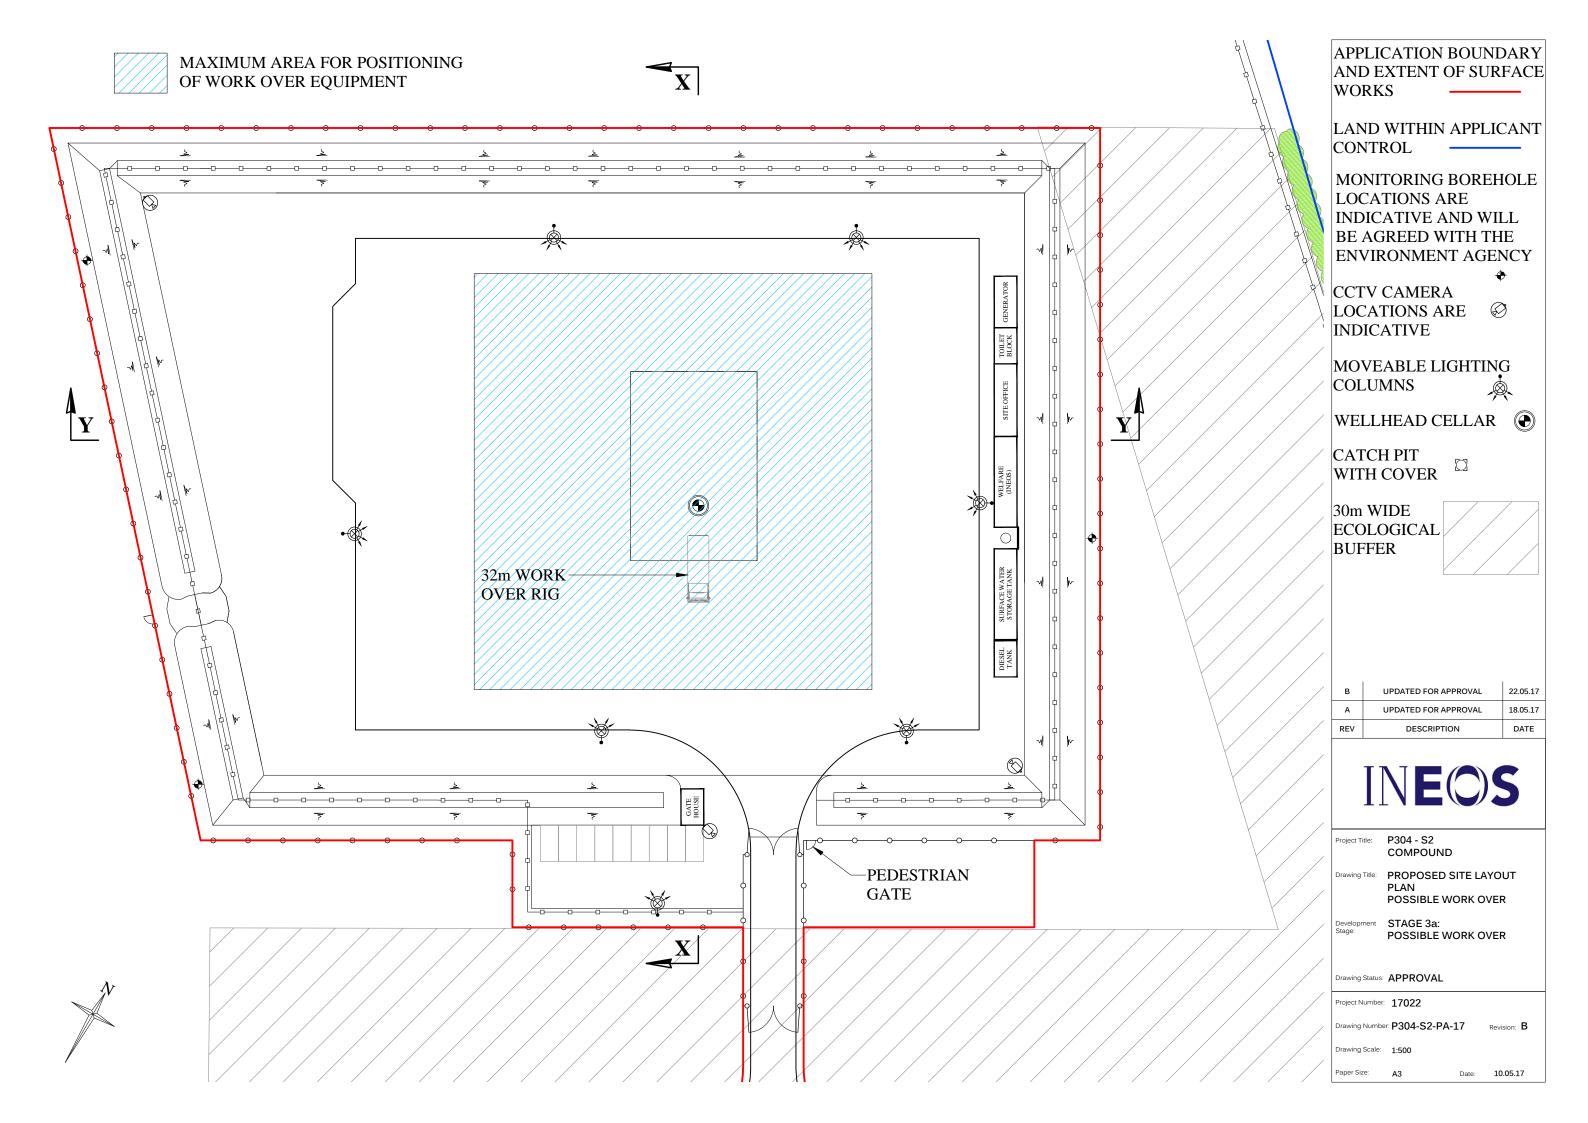

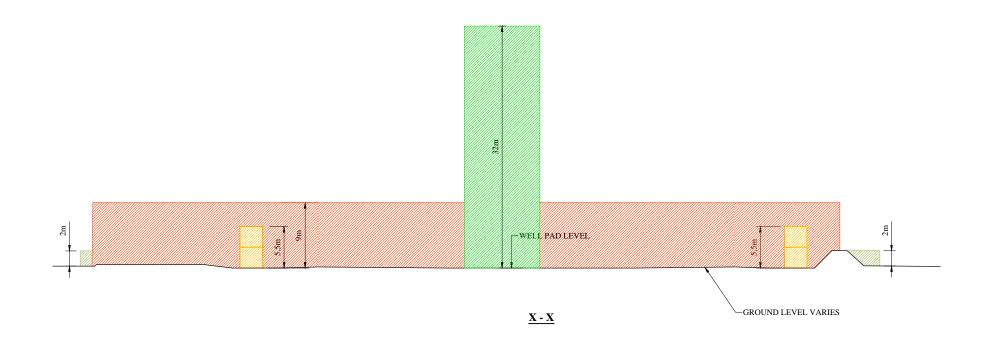

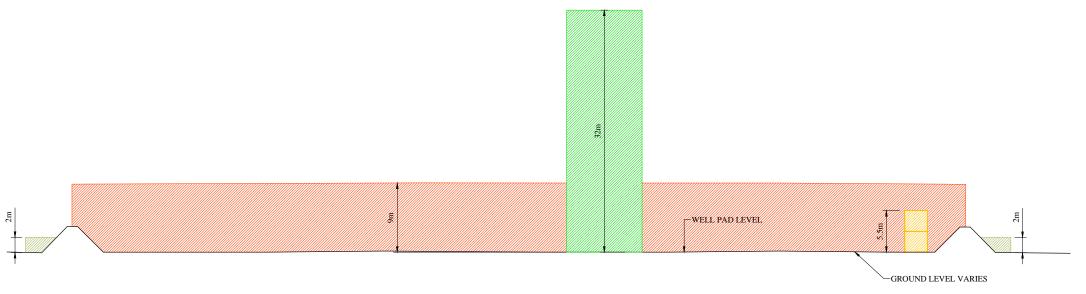

ZONE FOR HERAS FENCING MAXIMUM HEIGHT 2m

MAXIMUM HEIGHT OF DOUBLE STACKED CABINS 5.5m



ZONE FOR OPERATIONAL SITE FENCING MAXIMUM HEIGHT 7m LIGHTING & CCTV COLUMNS MAXIMUM HEIGHT 9m

ZONE FOR CONDUCTOR / SURFACING RIG MAXIMUM HEIGHT 32m

UPDATED FOR APPROVAL REV DESCRIPTION Project Title: P304 - S2 COMPOUND

Drawing Title: PARAMETER SECTIONS

Development STAGE 1: SITE DEVELOPMENT AND ESTABLISHMENT

18.05.17

DATE


Drawing Status: APPROVAL

Project Number: 17022

Drawing Number: P304-S2-PA-21 Revision: A

Drawing Scale: 1:500

Paper Size: A3 Date: 10.05.17

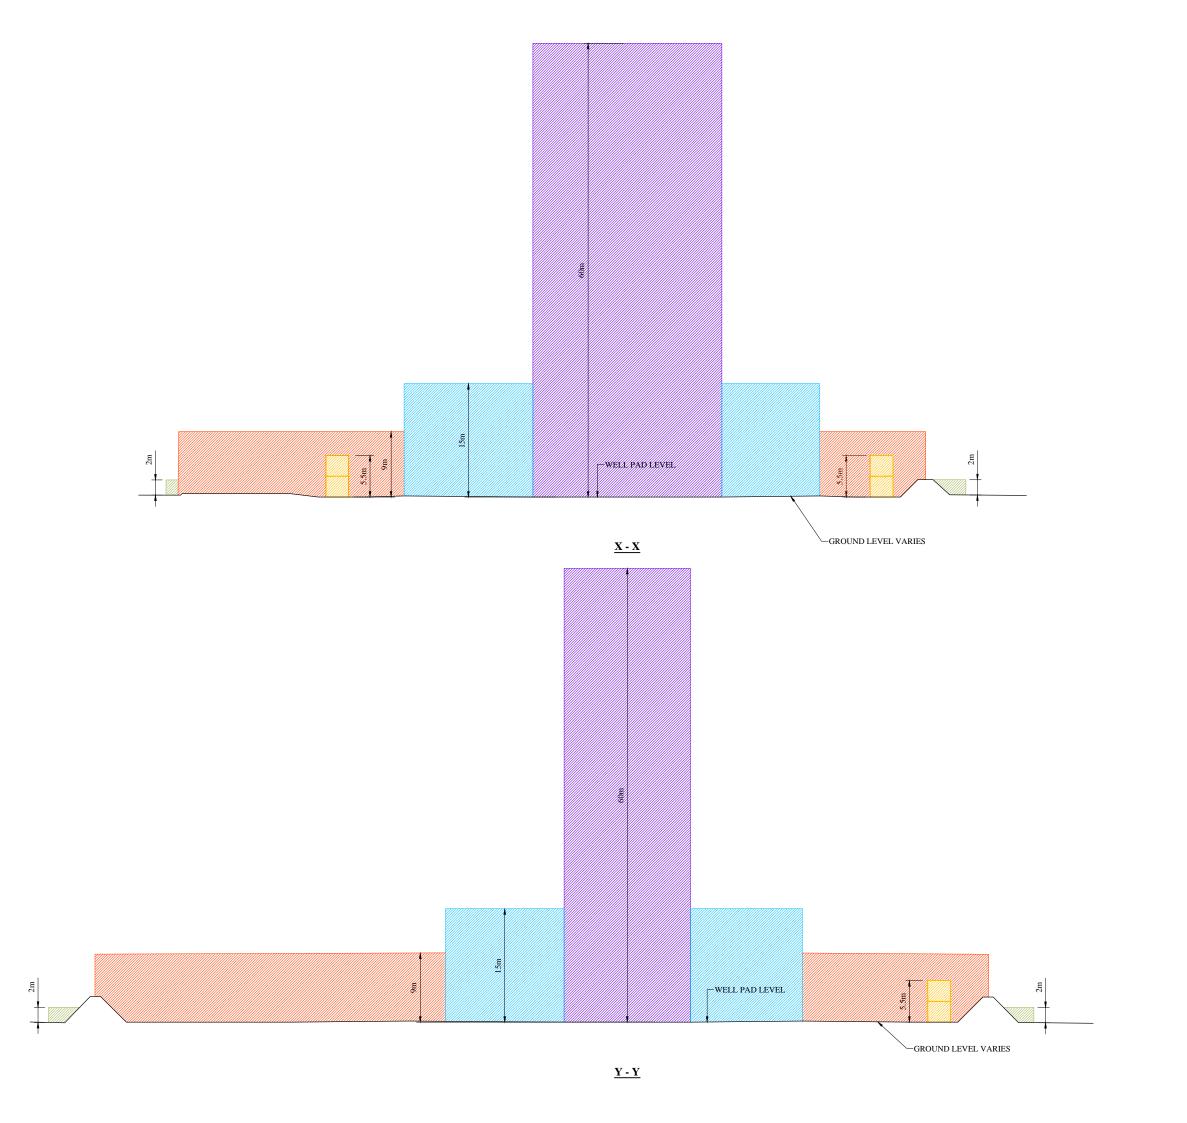

ZONE FOR HERAS FENCING MAXIMUM HEIGHT 2m

MAXIMUM HEIGHT OF DOUBLE STACKED CABINS 5.5m

ZONE FOR OPERATIONAL SITE FENCING MAXIMUM HEIGHT 7m LIGHTING & CCTV COLUMNS MAXIMUM HEIGHT 9m

ZONE FOR SUBSTRUCTURE & ANCILLARY DRILLING EQUIPMENT MAXIMUM HEIGHT 15m

ZONE FOR DRILLING RIG MAXIMUM HEIGHT 60m

18.05.17 APPROVAL DATE REV DESCRIPTION

Project Title: P304 - S2

COMPOUND

Drawing Title: PARAMETER SECTIONS

Development STAGE 2: DRILLING, CORING AND SUSPENSION

Drawing Status: APPROVAL


Project Number: 17022

Drawing Number: P304-S2-PA-22 Revision: A

Drawing Scale: 1:500

Paper Size: A3

Date: 10.05.17

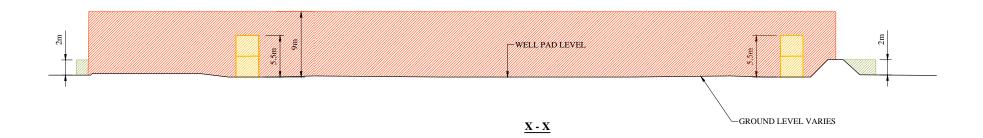



ZONE FOR HERAS FENCING MAXIMUM HEIGHT 2m


MAXIMUM HEIGHT OF DOUBLE STACKED CABINS 5.5m


ZONE FOR OPERATIONAL SITE FENCING MAXIMUM HEIGHT 7m LIGHTING & CCTV COLUMNS MAXIMUM HEIGHT 9m

UPDATED FOR APPROVAL 18.05.17 REV DATE DESCRIPTION Project Title: P304 - S2 COMPOUND Drawing Title: PARAMETER SECTIONS Development STAGE 3: MAINTENANCE AND SUSPENSION WELL Drawing Status: APPROVAL Project Number: 17022 Drawing Number: P304-S2-PA-23 Revision: A Drawing Scale: 1:500

Date: 10.05.17

Paper Size: A3

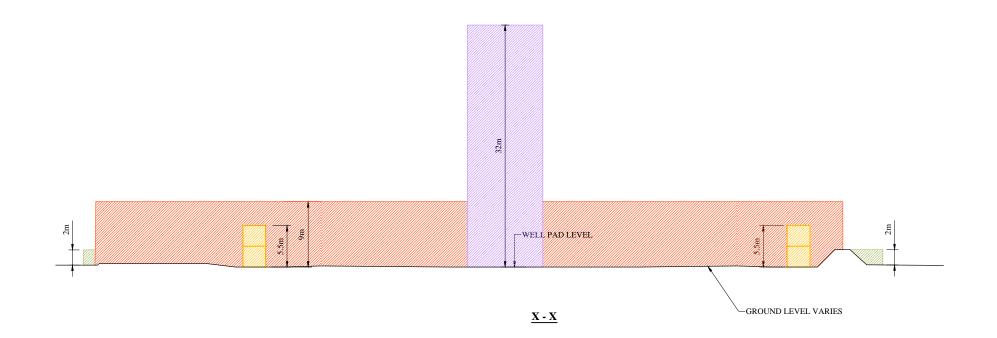

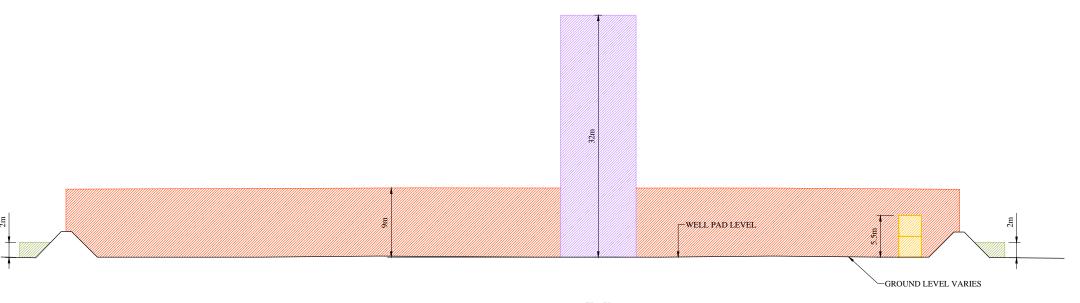

ZONE FOR HERAS FENCING MAXIMUM HEIGHT 2m

MAXIMUM HEIGHT OF DOUBLE STACKED CABINS 5.5m

ZONE FOR OPERATIONAL SITE FENCING MAXIMUM HEIGHT 7m LIGHTING & CCTV COLUMNS MAXIMUM HEIGHT 9m

ZONE FOR WORK OVER RIG MAXIMUM HEIGHT 32m

UPDATED FOR APPROVAL 18.05.17 DATE REV DESCRIPTION



Project Title: P304 - S2 COMPOUND

Drawing Title: PARAMETER SECTIONS

Development STAGE 3a: POTENTIAL WORK OVER OF WELL


Drawing Status: APPROVAL


Project Number: 17022

Drawing Number: P304-S2-PA-24 Revision: A

Drawing Scale: 1:500

Paper Size: A3 Date: 10.05.17

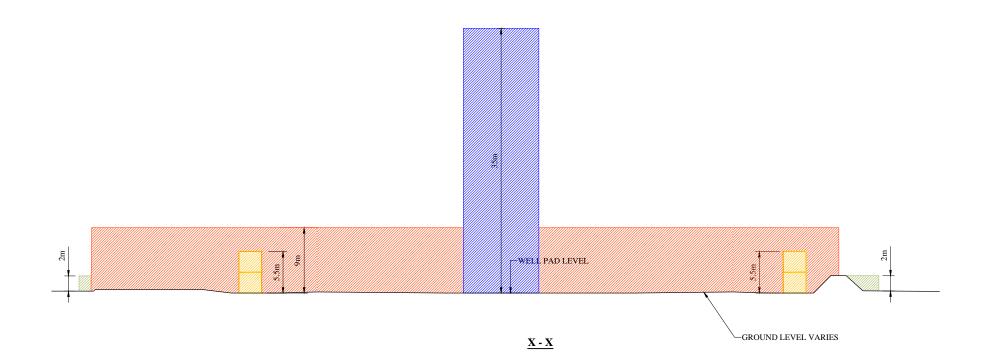

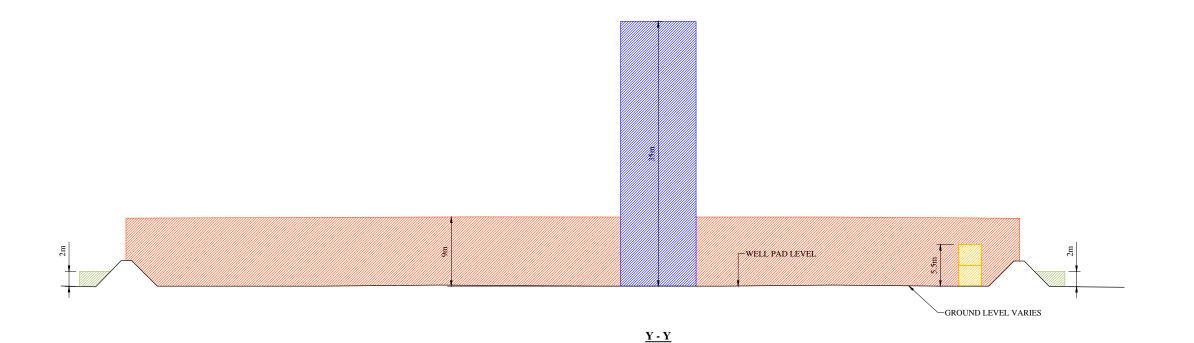

ZONE FOR HERAS FENCING MAXIMUM HEIGHT 2m

MAXIMUM HEIGHT OF DOUBLE STACKED CABINS 5.5m

GHT OF DOUBLE INS 5.5m

ZONE FOR OPERATIONAL SITE FENCING MAXIMUM HEIGHT 7m LIGHTING & CCTV COLUMNS MAXIMUM HEIGHT 9m

SITE HT 7m INS

ZONE FOR CRANE AND LISTENING EQUIPMENT MAXIMUM HEIGHT 35m

A UPDATED FOR APPROVAL

REV DESCRIPTION DATE

INECS

Project Title: P304 - S2
COMPOUND

Drawing Title: PARAMETER SECTIONS

Development Stage: STAGE 4: LISTENING STAGE

Drawing Status: APPROVAL

Project Number: 17022

Drawing Number: P304-S2-PA-25 Revision: A

Drawing Scale: 1:500

Paper Size: A3 Date: 10.05.17

ORIGINAL LAND PROFILE

SITE TO BE RESTORED TO ORIGINAL LAND PROFILE

<u>X - X</u>

A UPDATED FOR APPROVAL

REV DESCRIPTION DATE

INTERMISE

Project Title: P304 - S2
COMPOUND

Drawing Title: PARAMETER SECTIONS

Development STAGE 5: ABANDONMENT AND RESTORATION

Drawing Status: APPROVAL


Project Number: 17022

Drawing Number: P304-S2-PA-26 Revision: A

Drawing Scale: 1:500

Date: 10.05.17

Paper Size: A3

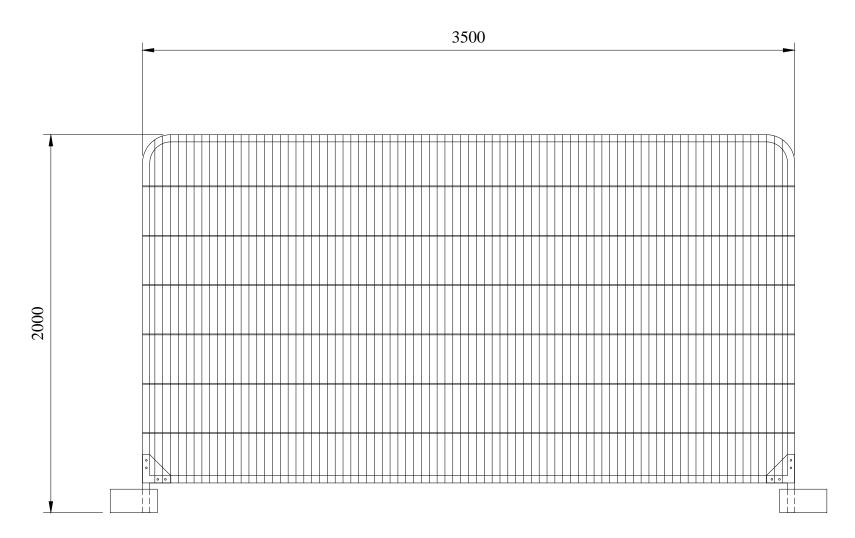

HERAS PANEL SPECIFICATIONS

PANEL DIMENSIONS 2000mm (H) 3500mm (W)


HORIZONTAL TUBE 38.1mm VERTICAL TUBE 38.1mm REINFORCED CORNERS YES WEIGHT 17kg

FINISH COLOUR TO BE AGREED

WITH MINERALS

PLANNING AUTHORITY

HERAS ROUND TOP PANEL

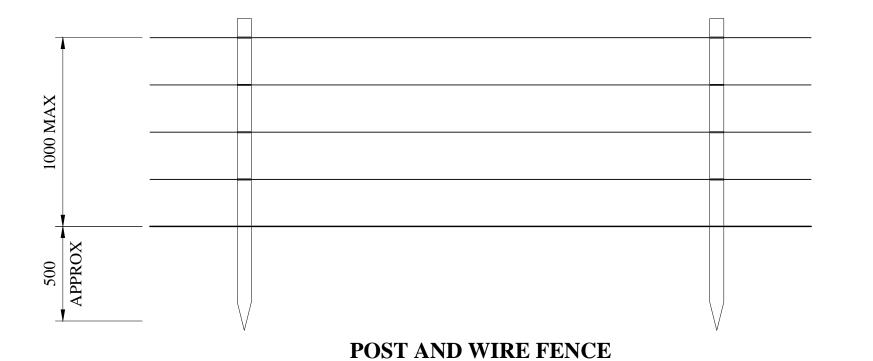


POST AND WIRE FENCE SPECIFICATIONS

POSTS MIN 1500mm (L) 75mmØ TREATED SOFTWOOD POST CENTRES 2000mm - 3000mm

WIRE TYPE COLOUR AND MATERIAL

TO BE AGREED WITH MINERALS PLANNING

AUTHORITY

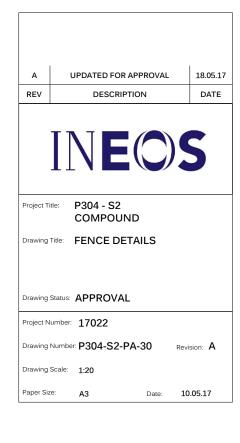

EXAMPLES OF THE PROPOSED LIGHTING UNITS ARE:

TOWARDS TOMORROW ENERGY - TTE-FL-80	80W LED FLOODLIGHT SILVER POWDER COATED ALLOY SENSOR COMPATIBLE SIZE 365mm x 285mm x 120mm
DESIGNPLAN LIGHTING - QUADRATO	22W LED BLACK POWDER COATED DIE CAST ALUMINIUM BODY SENSOR COMPATIBLE SIZE 305mm x 305mm x 145mm
DESIGNPLAN LIGHTING - BERGEN	21W LED TITANIUM POWDER COATED STEEL SIZE 400mm x 200mm x 100mm
VT1 ECO LIGHTING TOWER 9m	10kva MOVABLE UNIT WITH 360° ROTATION

